

BID SET

Revisions:


1/16/20	03 Comments - See Revisions

PROJECT NAME:

PALM AIRE PARK


PROJECT ADDRESS:
 3500 West Palm Aire Drive
 Pompano Beach, Florida

KEY PLAN

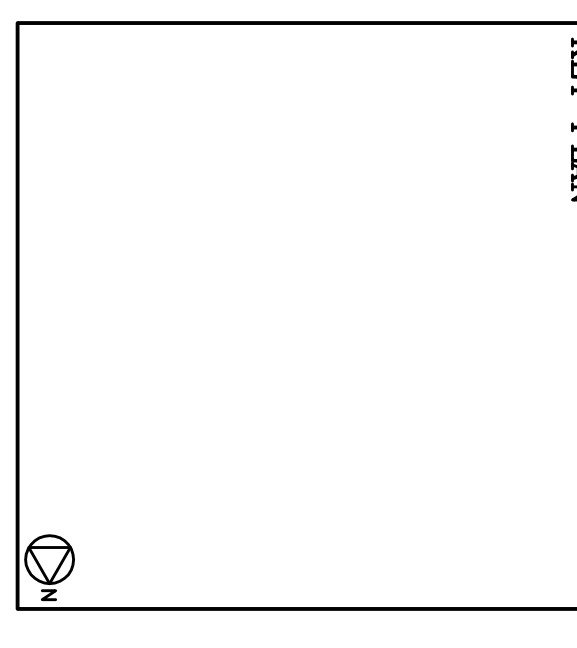


PROJECT NO. 10534.00
 SCALE: 1" = 10'-0"
 DATE: September 14, 2010
 DRAWN: JH
 CHECKED: JY
 CADD FILE:


EROSION CONTROL DETAILS

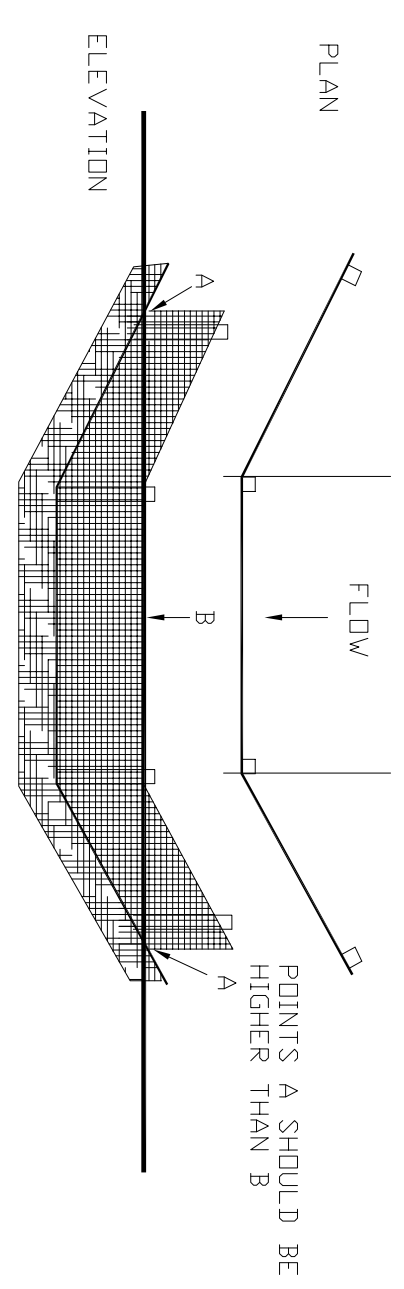

PROPER PLACEMENT OF A FILTER BARRIER IN A DRAINAGE WAY

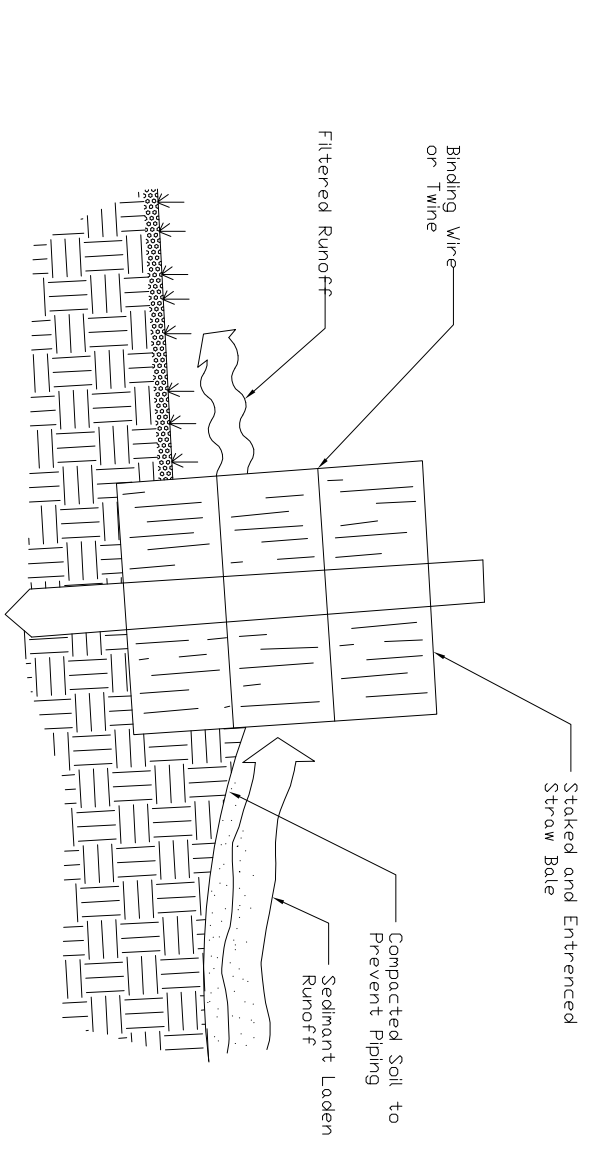



CROSS-SECTION OF A PROPERLY INSTALLED STRAW BALE

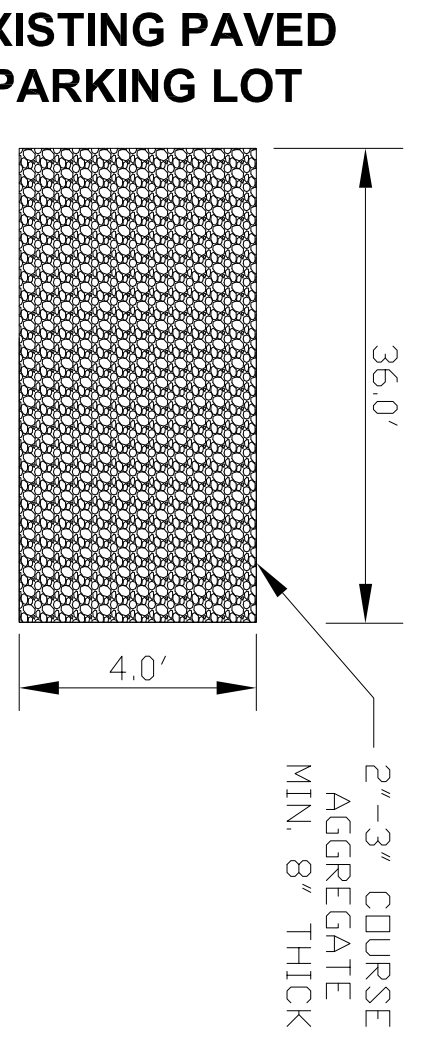

NOTES:

1. THE ENTRANCE SHALL BE MAINTAINED IN A CONDITION THAT WILL PREVENT TRACKING OR FLOWING OF SEDIMENT ONTO PUBLIC RIGHTS-OF-WAY. THIS MAY REQUIRE TOP DRESSING, REPAIR AND/OR CLEANOUT OF ANY MEASURES USED TO TRAP SEDIMENT.
2. WHEN NECESSARY, WHEELS SHALL BE CLEANED PRIOR TO ENTRANCE ONTO PUBLIC RIGHTS-OF-WAY.
3. WHEN WASHING IS REQUIRED, IT SHALL BE DONE ON AN AREA STABILIZED WITH CRUSH STONE THAT DRAINS INTO APPROVED SEDIMENT TRAP OR SEDIMENT BASIN.


STABILIZED CONSTRUCTION ENTRANCE

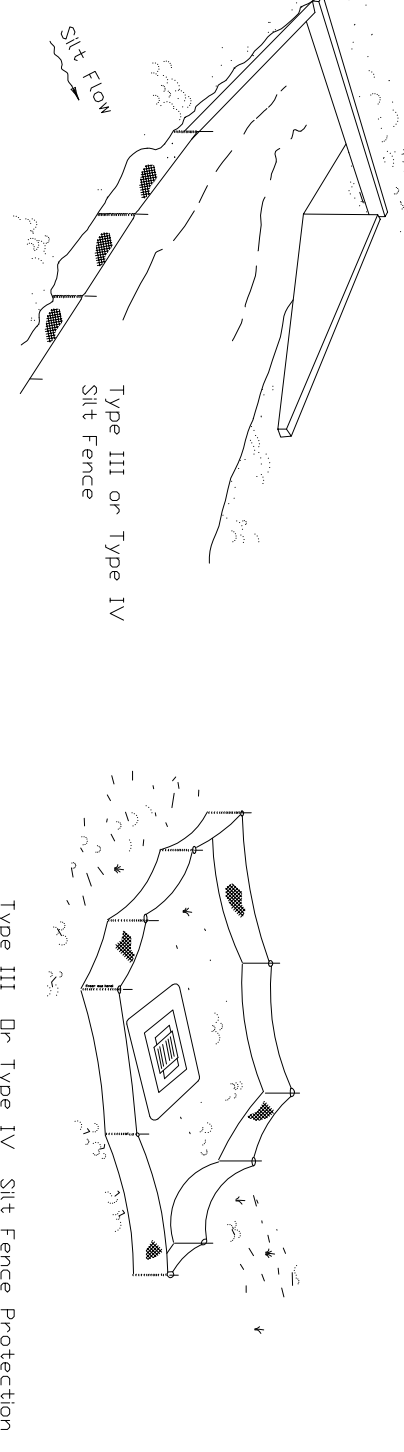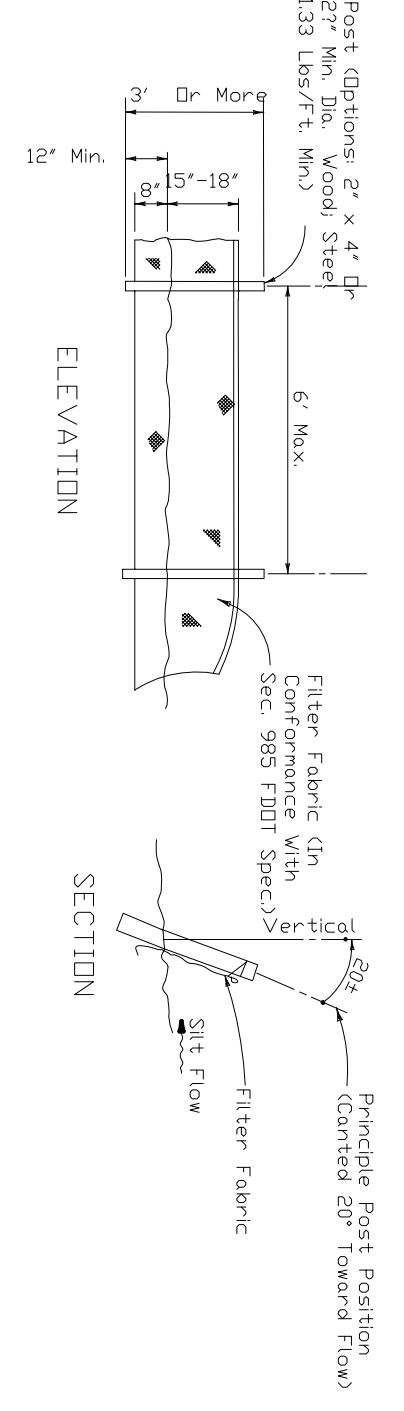


SILT FENCE APPLICATIONS

- Do not install in a manner that a silt fence will act as a flow control point. Flowing water over a silt fence may be used as an initial indicator and surchase warning of a water.
- Silt Fence Type I or Type IV
 Silt Fence Type II or Type III
 Silt Fence Type III or Type IV

SILT FENCE

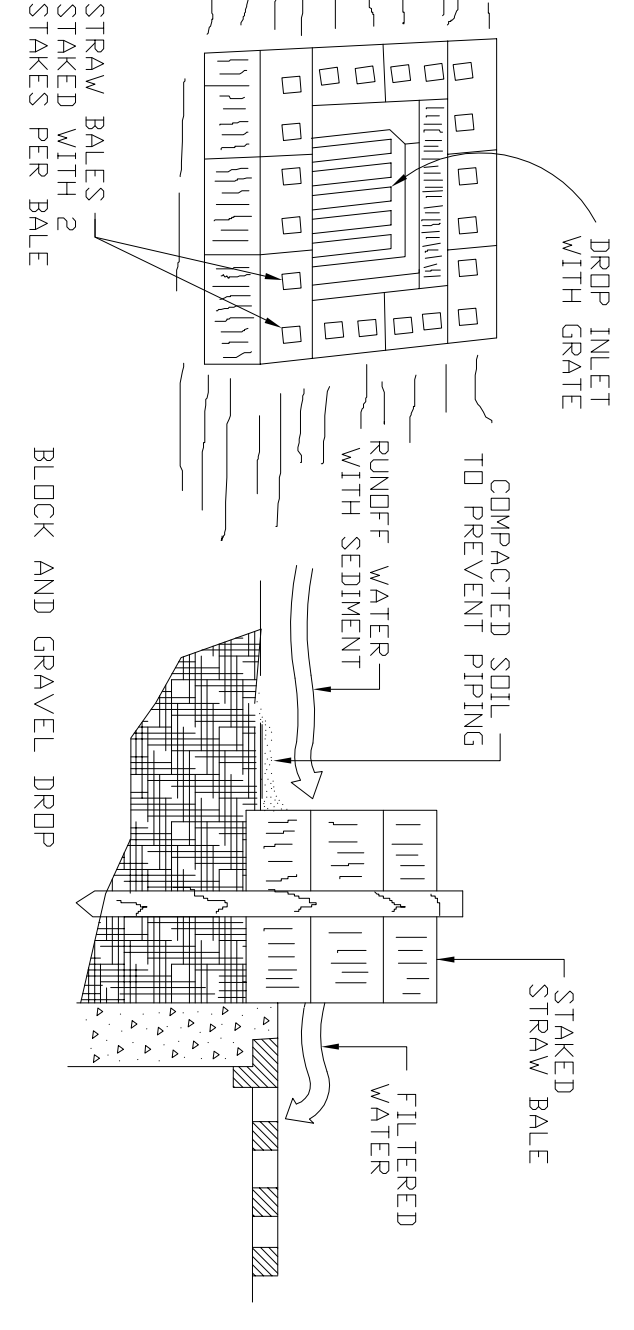


SPECIFIC APPLICATION

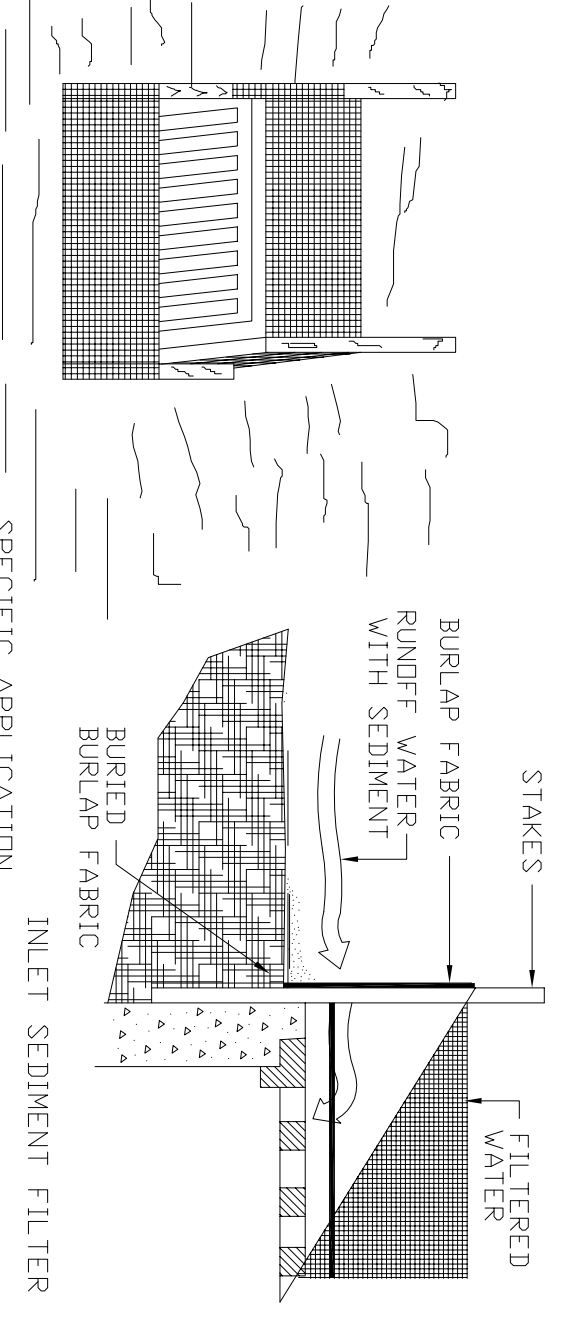


SPECIFIC APPLICATION

DROP INLET SEDIMENT FILTER

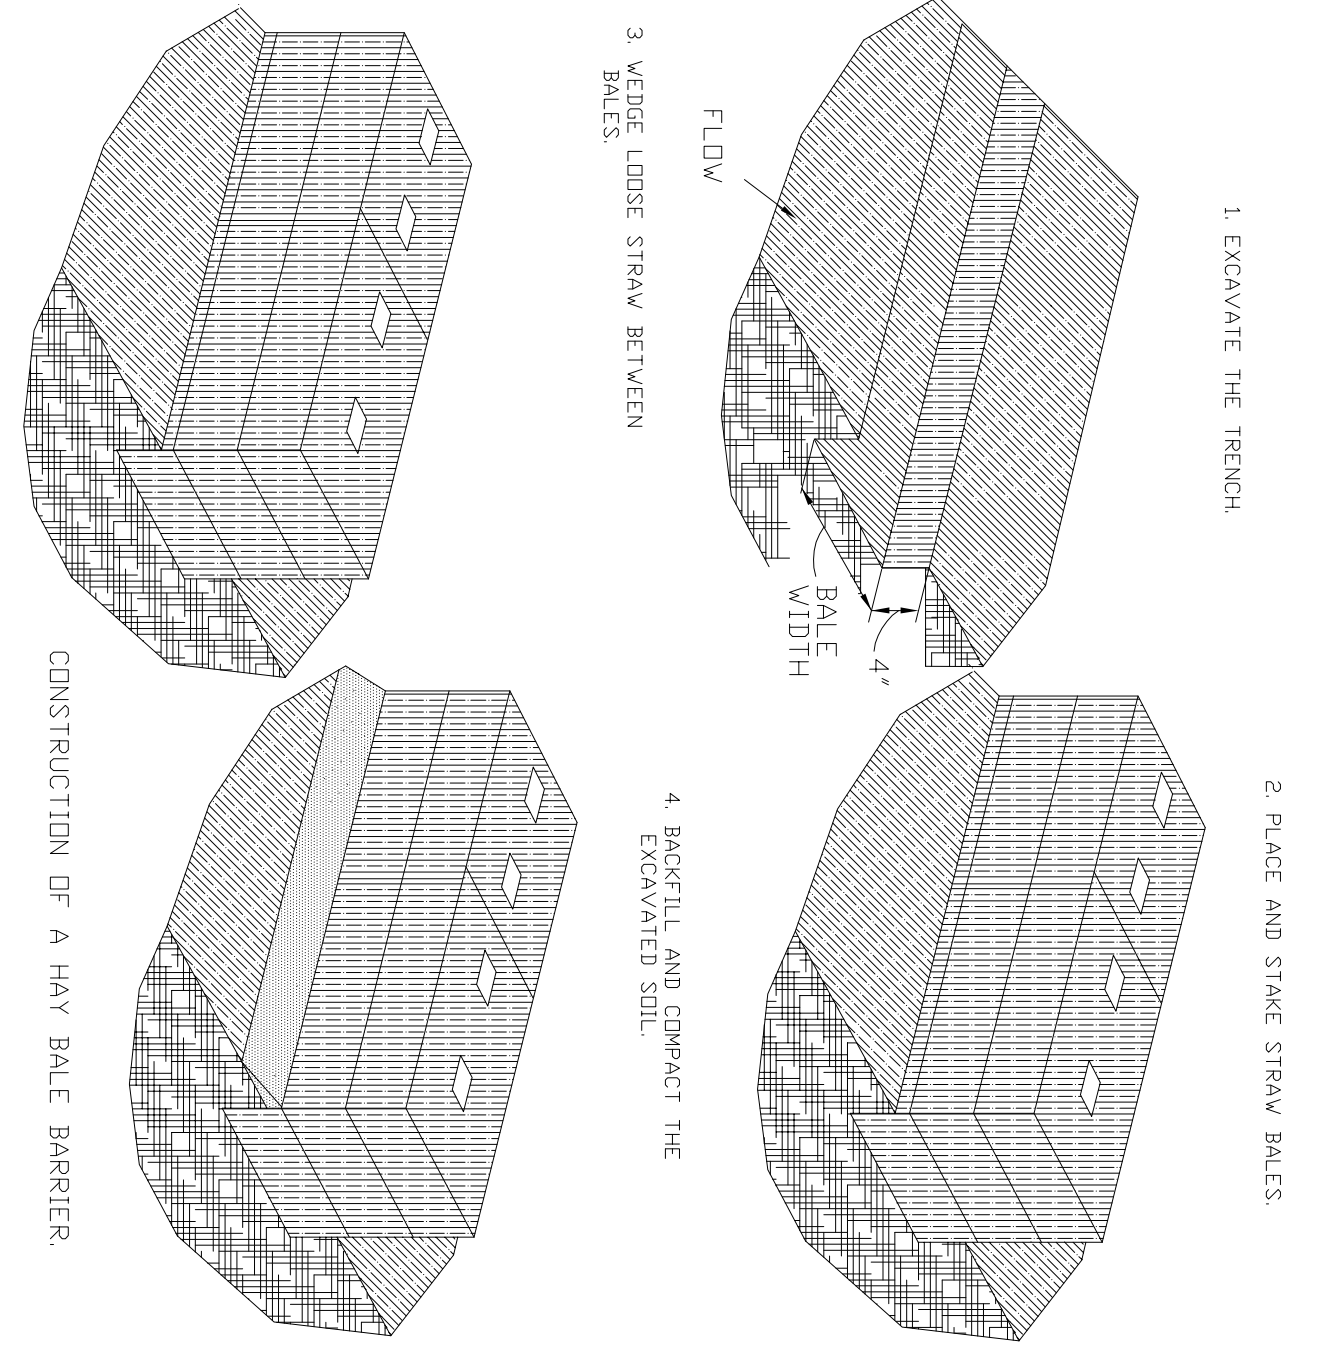

POINTS A SHOULD BE HIGHER THAN POINT B
 PROPER PLACEMENT OF HAY BALE BARRIER IN DRAINAGE WAY

HAY BALE BARRIER CONSTRUCTION DETAILS

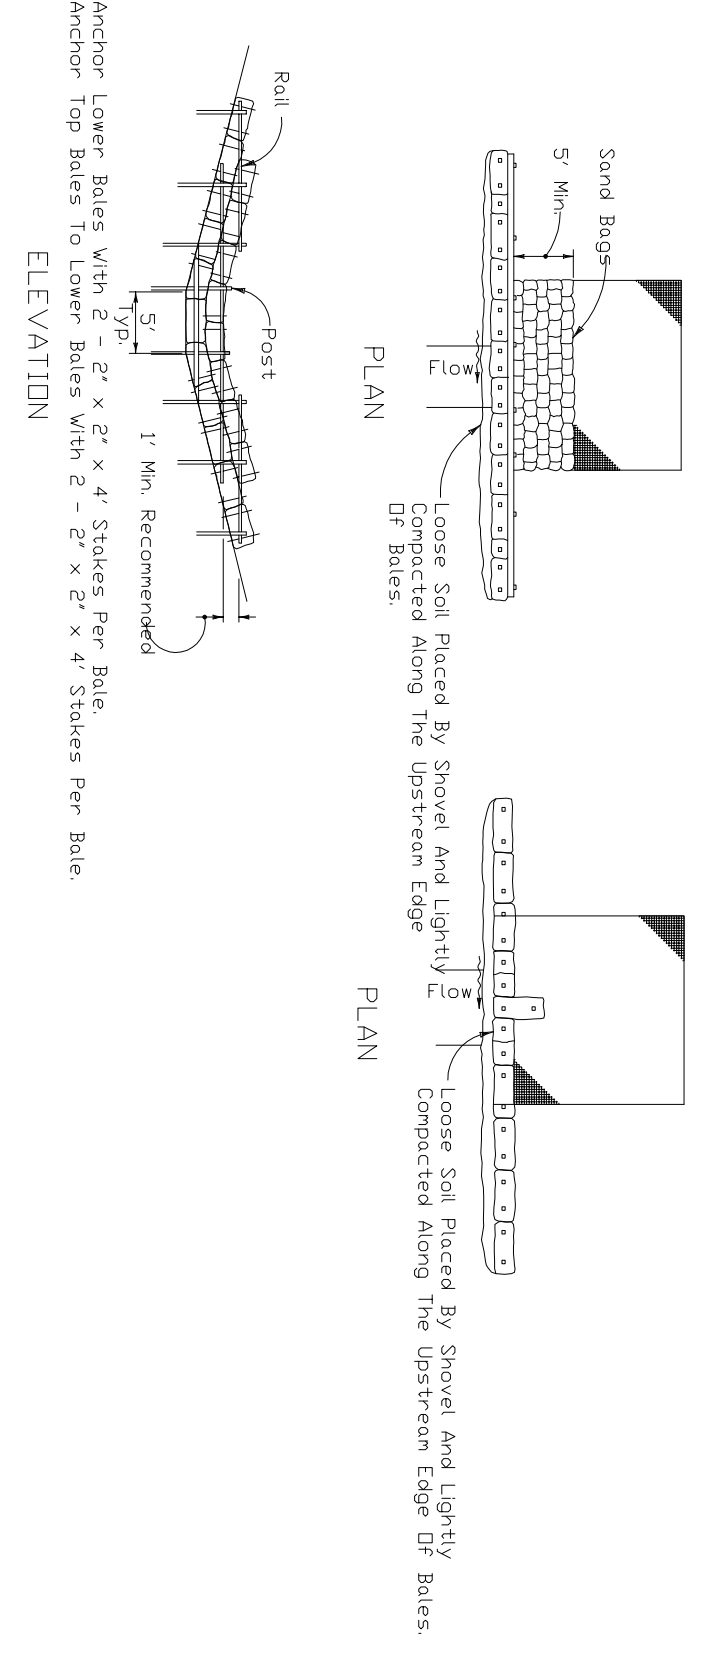

BARRIER FOR UNPAVED DITCHES

HAY BALE BARRIERS